Fibonacci Park - Detailed Design Documentation



Construction Documentation - How to Use Guide

Introduction

The following notes are intended to assist the contractor understand the organisation and structure of the Civille design documentation package. The package includes three separate documents that are cross referenced. These are the Plan Drawing Sheets, Construction Details and the Technical Specification. The contractor is required to refer to the three documents together to fully understand the construction intent. The project documentation package is organised into ten major categories [0000-9000] with a system of codes utilised to link major project components across the three documents.

Plan Drawina Sheets

The Drawing Sheets include the cover page, legend, key plan, and other general information. For each sheet, an Existing Site Plan, Demolition Plan, Levels and Contours Plan, Materials & Finishes Plan, Planting Plan, and Civil Plan are provided as required to enable construction. A consolidated legend on the second drawing sheet outlines the major components and their corresponding codes. The Drawing Sheets may also contain long sections and elevations. The drawing sheets can be printed at a reduced scale on A3 size for ease of use on site however the contractor should refer firstly to the original size sheets.

Construction Details

This A3 document contains enlarged details from the drawing sheets and 3D model. Details may be drawn in section, elevation, axonometric, or 3D format.

Technical Specification

This A4 document contains the material descriptions, build methodology, standards, environmental requirements and quality expectations of the procurement and construction process.



www.civille.com.au

Client Uralla Shire Council Project Name

Uralla Parks Project No. 2145 Address Uralla, NSW

Documentation Categories

0000 General

demolition. 2000 Walls, Slabs + Edges 3000 Pavements & Civil Pedestrian and vehicular pavements. 4000 Site Structures 5000 Fences + Rails 6000 Water Elements 7000 Furniture + Fittings 8000 Planting 9000 Irrigation

The project documentation is organised into ten major categories that are found in all the contract documents. This project may not utilise all categories. The general content of each category is as follows:

Project Information, environmental performance, quality requirements, general materials requirements &

1000 Preparation, Groundworks & Drainage

Preparation & groundwork, earthworks, services trenching, drainage and soil works.

- Vertical and horizontal structural elements.

Unique structures that may be assembled from elements contained in other categories.

Fences, gates, balustrades, hand rails, grab rails and other barriers.

Ponds, wetlands and water sensitive urban design elements.

The palette of site furnishings including furniture, lighting, fittings and fixtures.

Botanical material including trees, shrub understorey, ground covers, herbs, aquatic plants and grasses.

Temporary and permanent automatic or manual watering systems.

Key Plan

Issue Log

A Draft for review B For Tender

JV/DK JV/DK

01/06/2022 21/06/2022

Date

Scale 1:100 @ A1 / 1:200 @ A3

Rev Description

By/Checked

All dimensions are in metres unless otherwise noted. Do not scale from this drawing.

Component Codes

To assist the contractor Civille uses a code system to describe the unique components contained in the package. These major components are identified by cedes called Types'. The ten documentation categories may contain a number of component 'Types'. For example, in the 200 category the project may contain a number of wall 'Types'. Each wall has a specific descriptor ie. t[wall0?]. The 't' identifies the component as a Type, 'wall' identifies that it is a wall and the '0?' is used to identify the particular wall. A wall t[wall0?] will be documented in the 200 category of the Construction Details whilst its physical attributes will be described in the Technical Specification. The location of all instances of the wall Type t[wall0?] will be indicated on the Drawing Sheets and its graphic properties described in the Drawing Sheets legend.

Site Set Out - Digital Files

Subject to copyright and if requested, Civille will make available a 2D or 3D digital design file to assist the contractor set out the works on site. The contractor should enquire with the Principal at tender stage to ascertain which types of file are available to assist with construction set out. The contractor is required to verify that any digital file provided by Civille is suitable for the intended use, has been translated correctly and is correctly geo-referenced prior to import into any device.

General Notes

The following notes apply to all the contract documents:

- All dimensions on the Drawing Sheets are in meters unless otherwise noted.
- All dimensions on the Construction Details are in millimeters unless otherwise noted.
- The contractor is not to scale from any printed drawing. The contractor must verify all dimensions on site and notify the Principal of any discrepancies prior to
- construction.
- -

The contractor must verify all existing services locations prior to excavation.

North

Phase **Tender Documentation** Sheet Title Cover Page Sheet No. PP-01

Rev

Fibonacci Park - Detailed Design Documentation

	LIST OF DRAWINGS	
SHEET No.	DESCRIPTION	REVISION
PLANS (PP)	PIONEER PARK PLANS	
PP-01	COVER PAGE	В
PP-02	DRAWING LIST & LEGEND	В
PP-03	SKETCH GUY CROSLEY	В
PP-100	EXISTING SITE PLAN	В
PP-101	DEMOLITION PLAN	В
PP-102	LEVELS & GRADING PLAN	В
PP-103	CUT & FILL PLAN	В
PP-104	MATERIALS & FINISHES PLAN	В
PP-105	PLANTING PLAN	В
SECTIONS (S)	PIONEER PARK SECTIONS	
PP-SO1	SECTIONS	В
RP-SO2	ELEVATION	В
DETAILS (D)	PIONEER PARK DETAILS	
1001	SOIL & PREPARATION; TREE PROTECTION	В
1002	SOIL & PREPARATION; SOIL MEDIA TYPES	В
2001	WALLS & EDGES; WALL TYPE 01	В
2002	WALLS & EDGES; WALL TYPE 02+03	В
2002	WALLS & EDGES; WALL TYPE 04	В
3001	PAVEMENTS	В
3002	PAVEMENTS	В
8001	PLANTING TYPICAL DETAILS	В

LEGEND

DEMOLITION

REMOVE TURF & PREPARE SUBGRADE	– – – CONTOURS MAJOR (1.00m INTERVALS)
REMOVE VEGETATION & PREPARE SUBGRADE	– – – CONTOURS MINOR (0.25m INTERVALS)
DEMOLISH PAVEMENT & BASE	+ FL 999.05 FINISH LEVELS
RELOCATE EXISTING STRUCTURE	+ EL 999.05 EXISTING LEVELS
NEW LOCATION RELOCATED STRUCTURE	+ TOW 999.45 TOP OF WALL LEVELS

 Θ 104/27-39 Abercrombie Street Chippendale NSW 2008 www.civille.com.au


Client Uralla Shire Council

Project Name

Uralla Parks Project No. 2145 Address Uralla, NSW

LEVELS & GRADING

MATERIALS & FINISHES

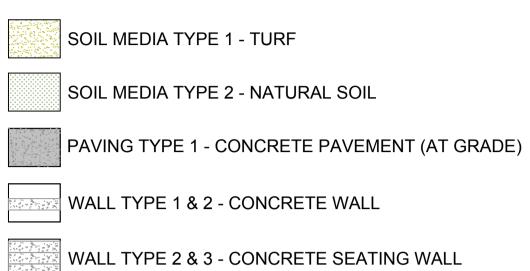

Key Plan

Issue Log

A Draft for review B For Tender

JV/DK JV/DK 01/06/2022 21/06/2022

Date

Scale

By/Checked

PLANTING




×

NATIVE MASSED PLANTING 1 NATIVE MASSED PLANTING 2 TREE PROPOSED



Phase Tender Documentation Sheet Title Key Plan & Transmittal Sheet Sheet No. PP-02

Fibonacci Park - Detailed Design Documentation

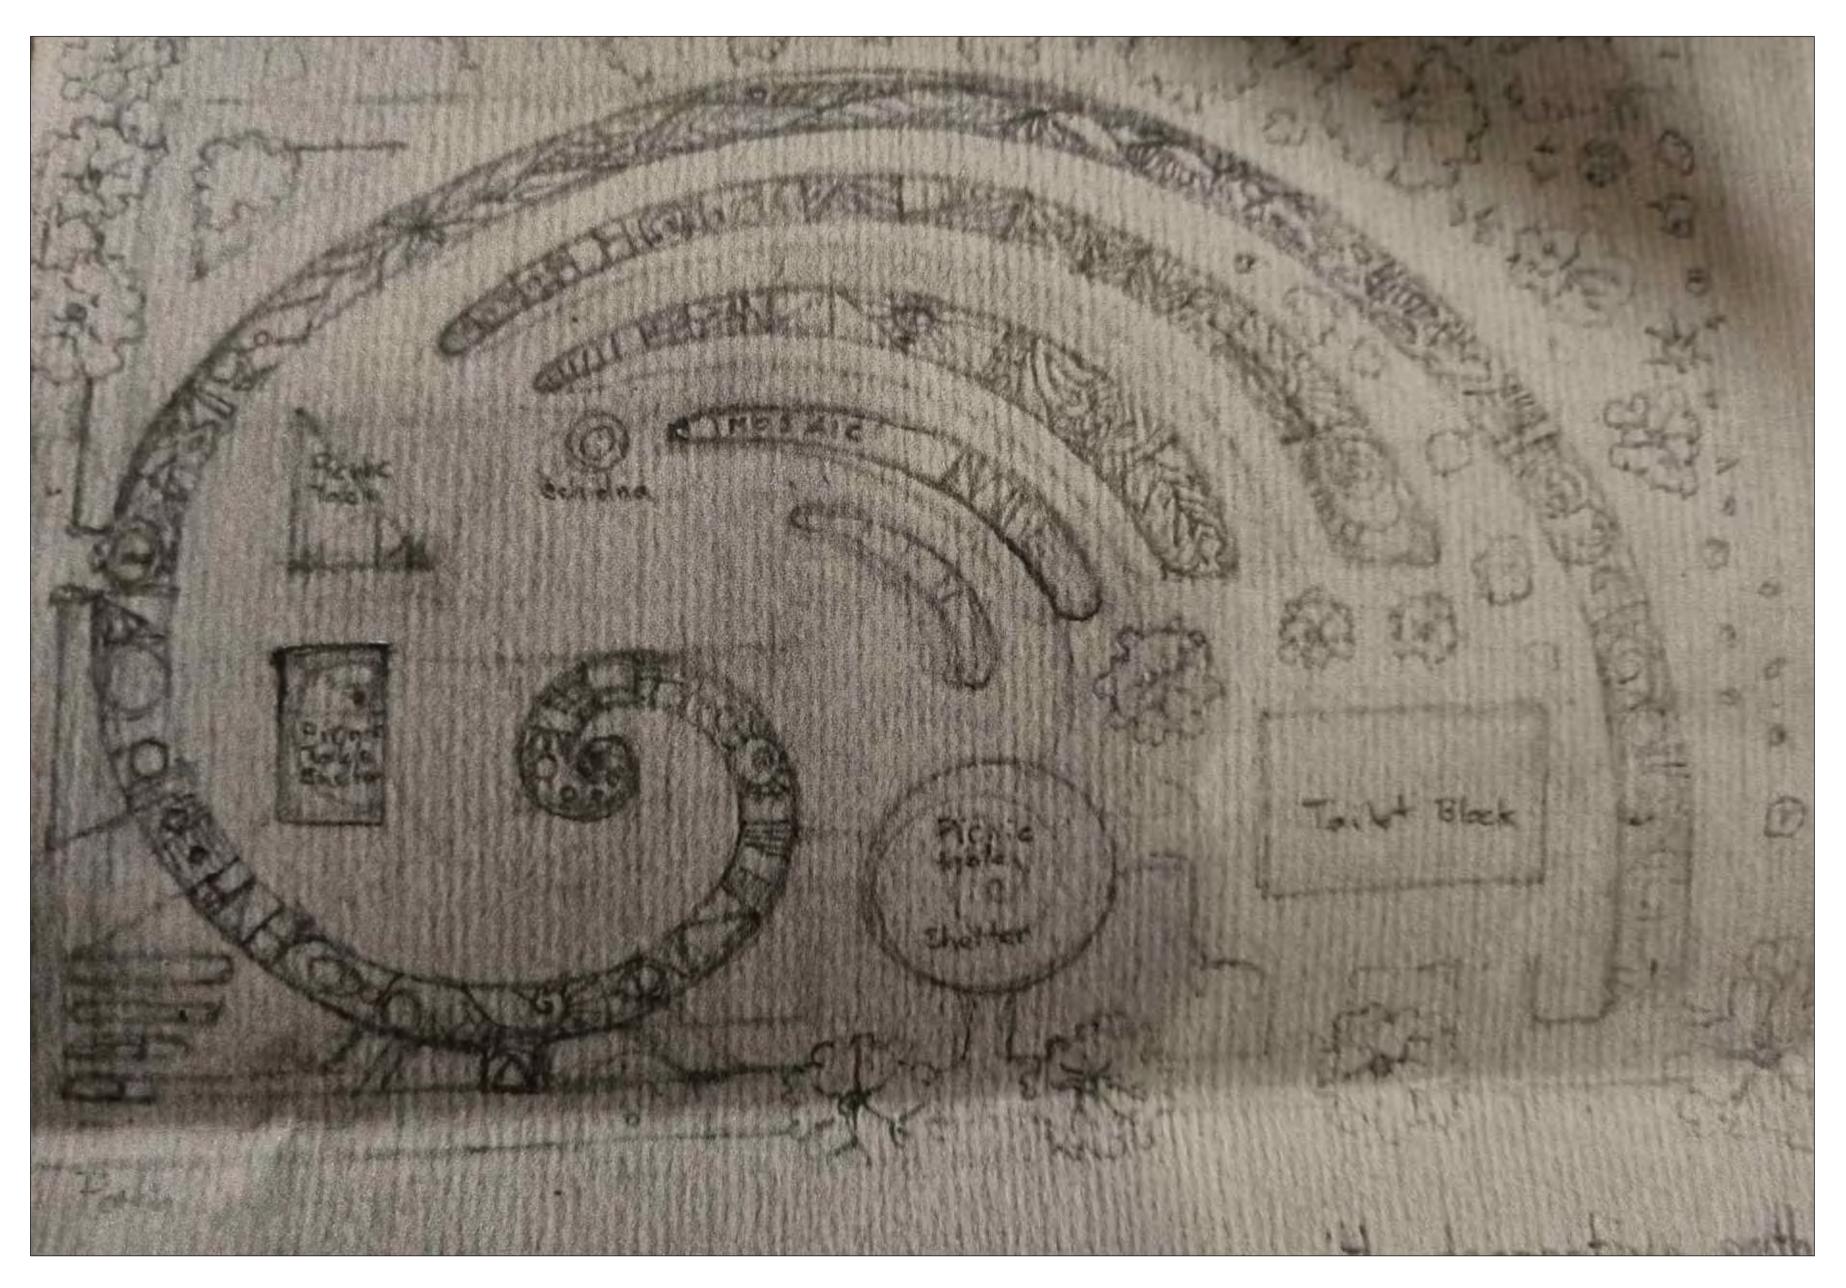

01

SKETCH OF FIBONACCI PARK BY GUY CROSLEY FOR VISUAL REFERENCE ONLY



_{Client} Uralla Shire Council

Project Name

Uralla Parks Project No. 2145 Address Uralla, NSW The Design for the upgrades of Fibonacci Park is based on a Guy Crosley sketch (as shown on this page) and consultation with the Uralla Community

Key Plan

Issue Log

A Draft for reviewB For Tender

JV/DK JV/DK

01/06/2022 21/06/2022

Date

Scale

By/Checked

Do not scale from this drawing.

Rev Description



Phase Tender Documentation Sheet Title Sketch Sheet No. PP-03





Client Uralla Shire Council

Project Name

Uralla Parks Project No. 2145 Address Uralla, NSW



Issue Log

A Draft for review B For Tender

01/06/2022 21/06/2022 JV/DK JV/DK

Scale 1:150 @ A1 / 1:300 @ A3

Rev Description


By/Checked

Date

All dimensions are in metres unless otherwise noted. Do not scale from this drawing.



Phase Tender Documentation Sheet Title Existing Site Plan Sheet No. PP-100

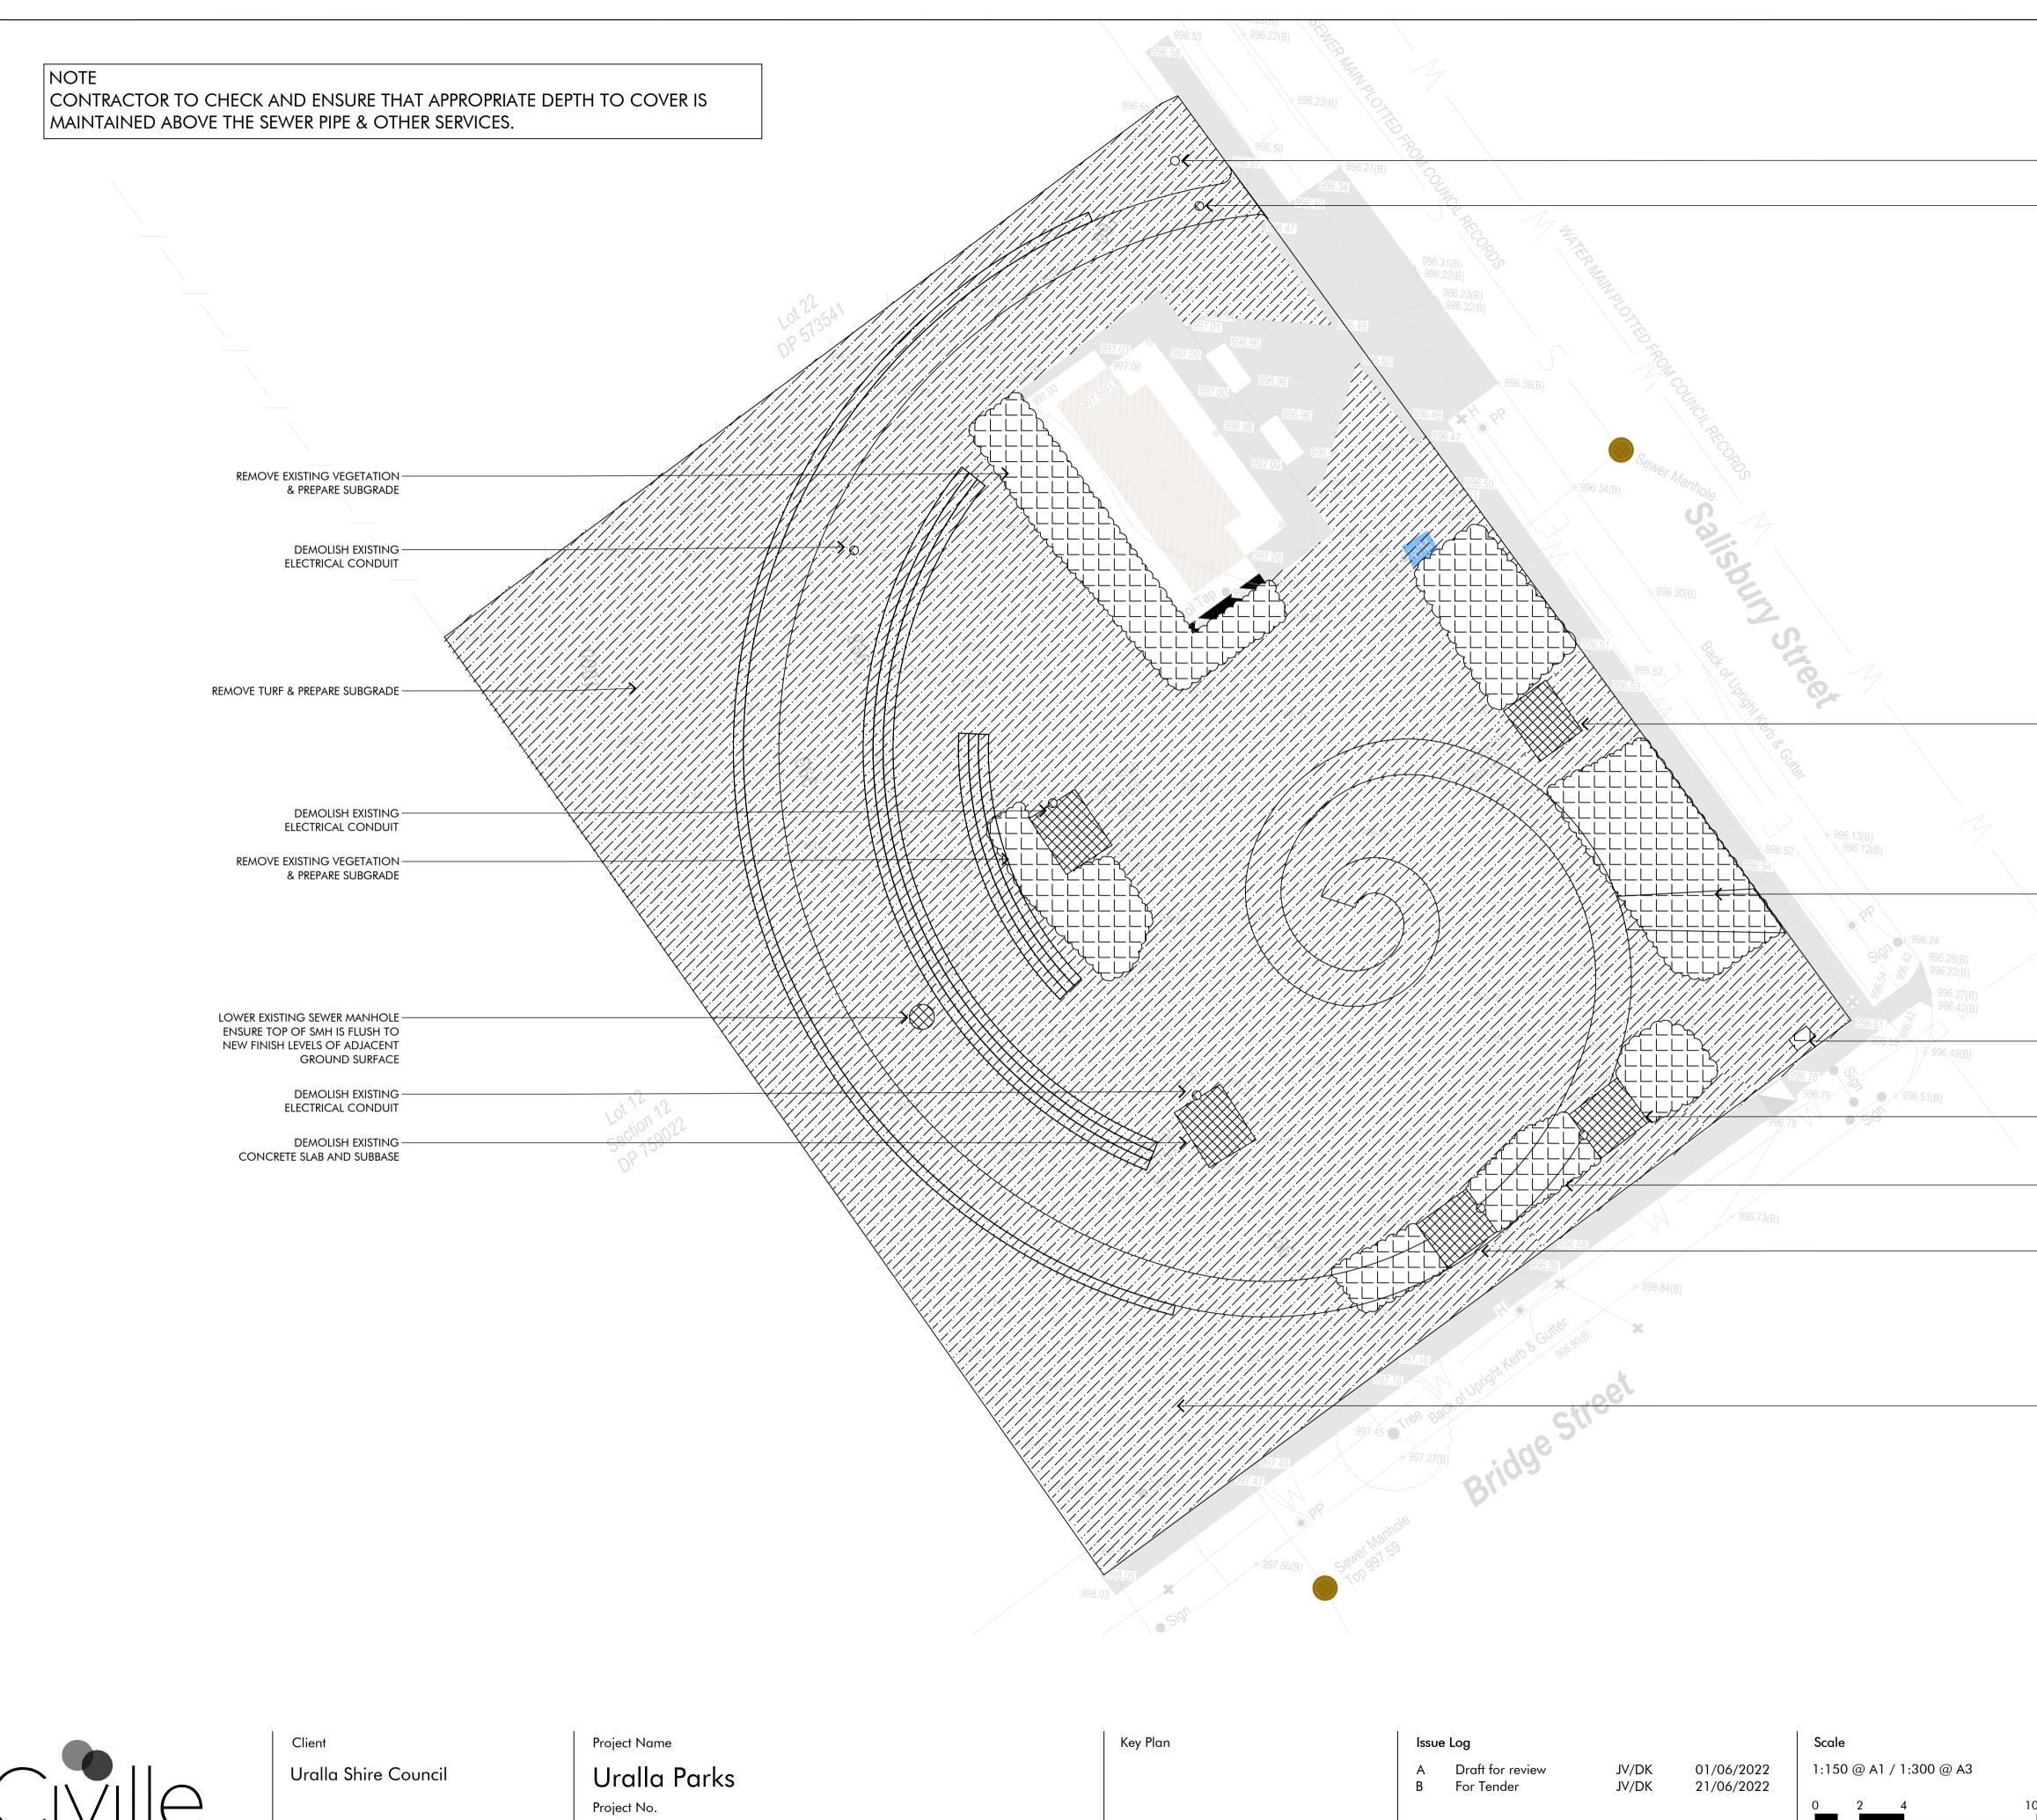

2145 Address Uralla, NSW



By/Checked

Date |

All dimensions are in metres unless otherwise noted. Do not scale from this drawing.

- NEW LOCATION FOR RELOCATED SIGN

- RELOCATE EXISTING SIGN

— DEMOLISH EXISTING FURNITURE, CONCRETE SLAB AND SUBBASE

- REMOVE EXISTING VEGETATION & PREPARE SUBGRADE

- DEMOLISH EXISTING CONCRETE PAD AND SUBBASE

- DEMOLISH EXISTING FURNITURE, CONCRETE SLAB AND SUBBASE

- REMOVE EXISTING VEGETATION & PREPARE SUBGRADE

- DEMOLISH EXISTING FURNITURE, CONCRETE SLAB AND SUBBASE

- REMOVE TURF & PREPARE SUBGRADE

North $(\top$

Phase Tender Documentation Sheet Title Demolition Plan Sheet No. PP-101

NOTE

CONTRACTOR TO CHECK AND ENSURE THAT APPROPRIATE DEPTH TO COVER IS MAINTAINED ABOVE THE SEWER PIPE & OTHER SERVICES.



Client Uralla Shire Council

Project Name

Uralla Parks Project No. 2145 Address Uralla, NSW

55

L 998.70

+ TOW 999.95

 \wedge <u>AL</u>

FL 999.45

.50

201

998.50

998.75

999.00-

+ FL 997.3

+ FL 997.60

+ FL 997.90

9880

TOW 1000

1/20

- 998.00-


098.

- 999.36

4 501

+ 999.85

3

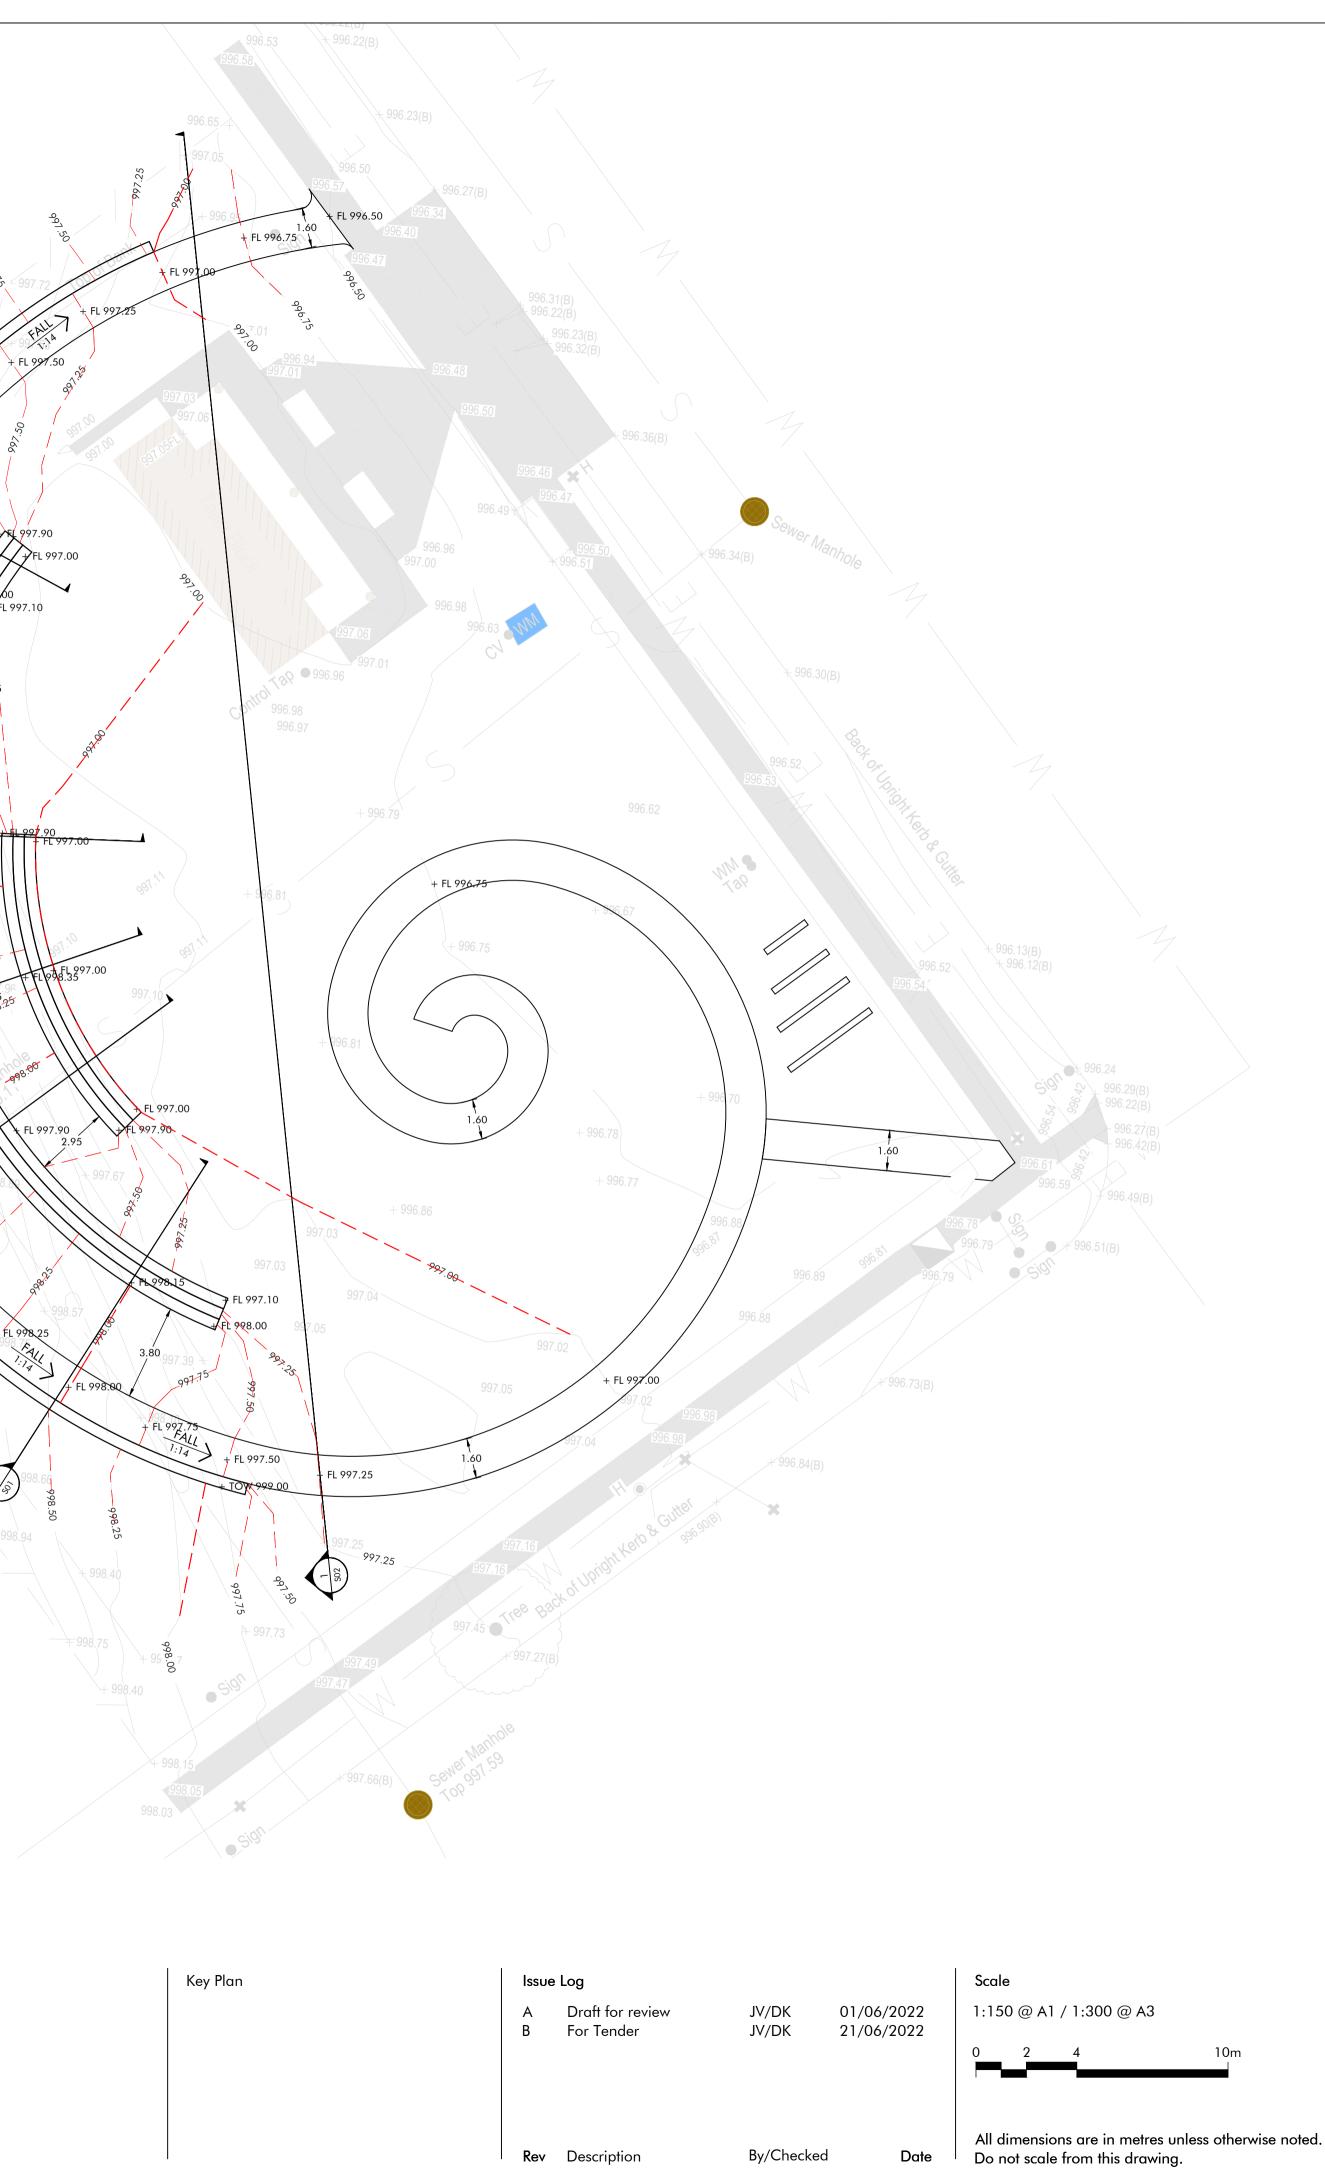

North \bigcirc

Phase Tender Documentation Sheet Title Levels & Grading Plan Sheet No. PP-102

CUT/FILL MODEL CALCULATED TO TOP OF SUBGRADE LEVELS

CONTRACTOR TO CHECK AND ENSURE THAT APPROPRIATE DEPTH TO COVER IS MAINTAINED ABOVE THE SEWER PIPE & OTHER SERVICES.




Client Uralla Shire Council

Project Name

Uralla Parks Project No. 2145 Address Uralla, NSW

999.48

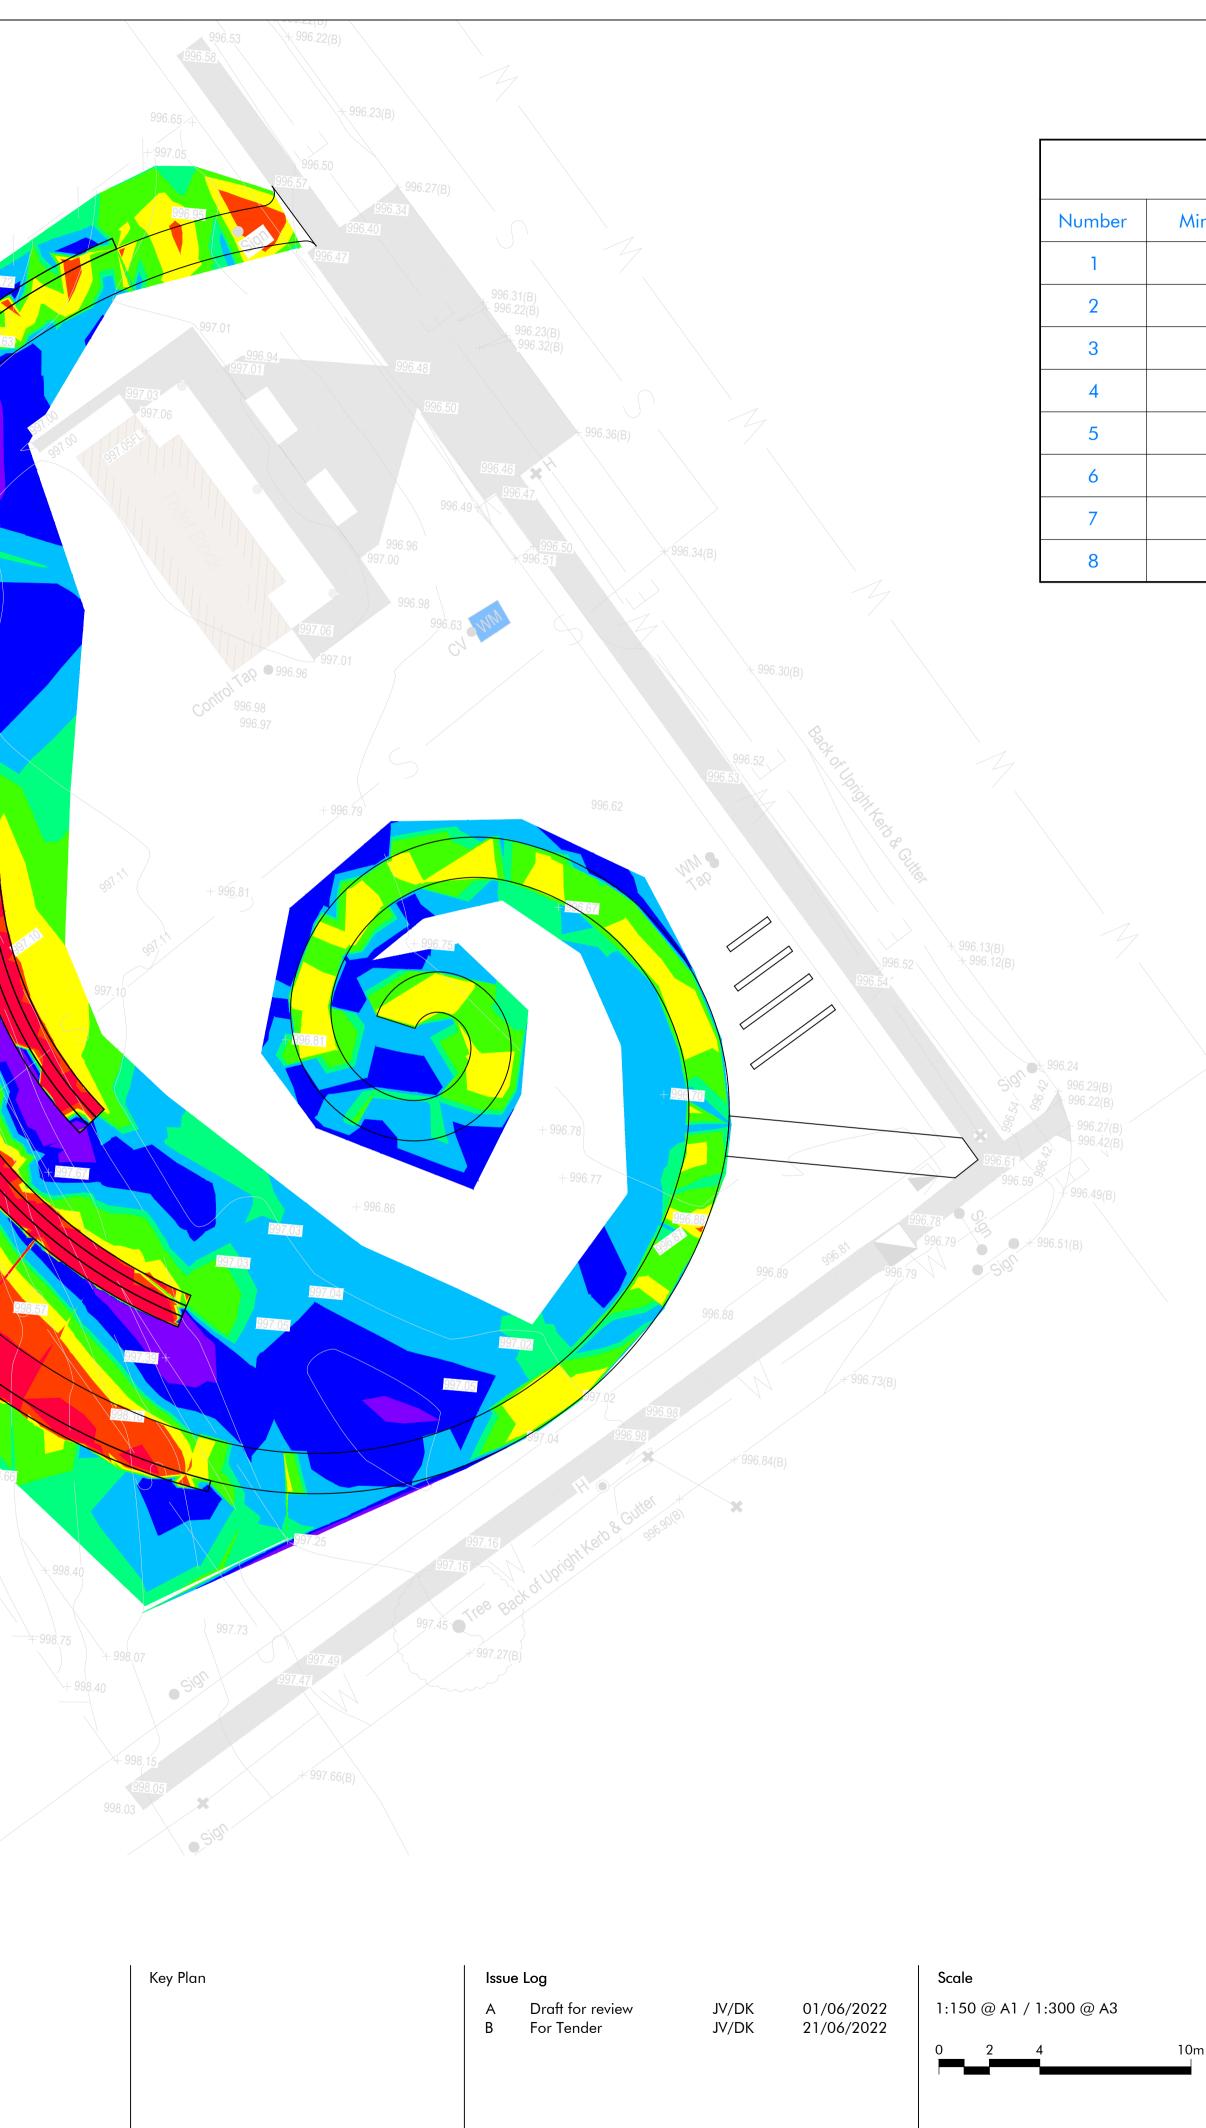

Date

All dimensions are in metres unless otherwise noted. Do not scale from this drawing.

Elevations Table					
Ainimum Elevation	Maximum Elevation	Area	Color		
-1.17	-0.45	89.40			
-0.45	-0.22	99.53			
-0.22	-0.10	135.69			
-0.10	-0.01	153.74			
-0.01	0.02	96.71			
0.02	0.11	210.31			
0.11	0.25	176.17			
0.25	0.97	104.23			

North $\left(\begin{array}{c} \\ \end{array} \right)$

Phase Tender Documentation Sheet Title Cut & Fill Plan Sheet No. PP-103





Client

Project Name Uralla Parks Project No. 2145 Address Uralla, NSW

Issue Log

A Draft for review B For Tender

01/06/2022 21/06/2022 JV/DK JV/DK

Scale 1:150 @ A1 / 1:300 @ A3 10m

Rev Description

By/Checked

Date

All dimensions are in metres unless otherwise noted. Do not scale from this drawing.



Phase Tender Documentation Sheet Title Materials & Finishes Plan Sheet No. PP-104





Client

Project Name

Uralla Parks Project No. 2145 Address Uralla, NSW

Key Plan

lssue	Log
-------	-----

A Draft for review B For Tender

Ø5/04/2022 21/06/2022 JV/DK JV/DK

Scale 1:150 @ A1 / 1:300 @ A3

Rev Description

By/Checked


Date |


All dimensions are in metres unless otherwise noted. Do not scale from this drawing.

Total area (m2) =	488		
S	Growth form	% of mix	total plants (tube)
da australis	Grass	20%	488
eberiana	Grass	15%	366
stipa stipoides	Grass	15%	366
cephalum apiculatum	Groundcover	10%	244
enia pinnatifida	Groundcover	10%	244
cum gramineum	Groundcover	10%	244
nia muelleri	Groundcover	10%	244
nbergia spp.	Gruondcover	10%	244
		100%	2440
wn - Kikuyu	Total a	rea <mark>(</mark> m2) =	1214
ees			
S	Growth form	size	
ndrum tulipifera	Tree	400L	5
emon viminalis	Tree / shrub	140mm	21
uca linariifolia	Tree	200L	1003
number of trees			31


North $(\)$

Phase Tender Documentation Sheet Title Planting Plan Sheet No. PP-105

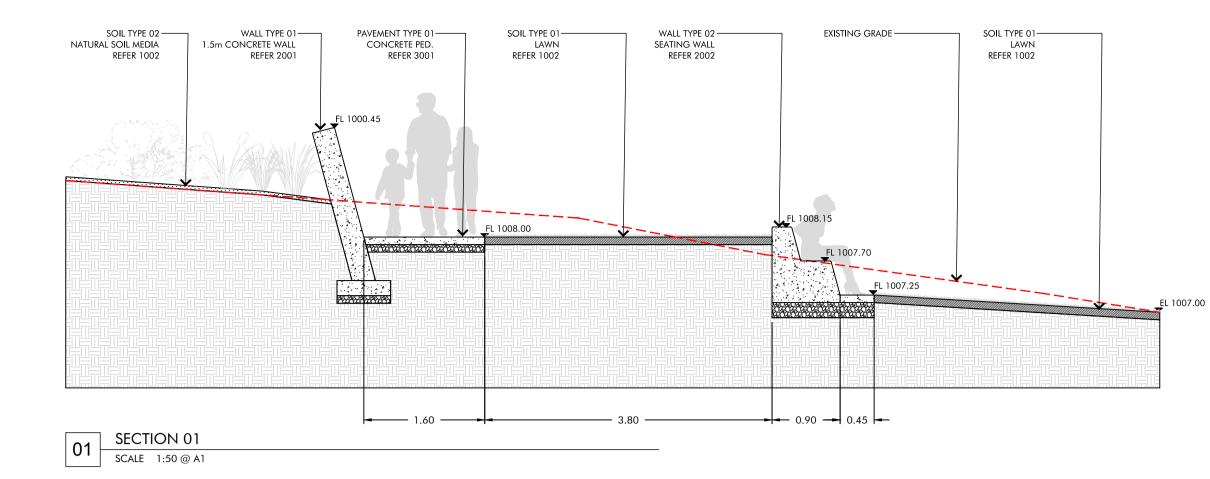

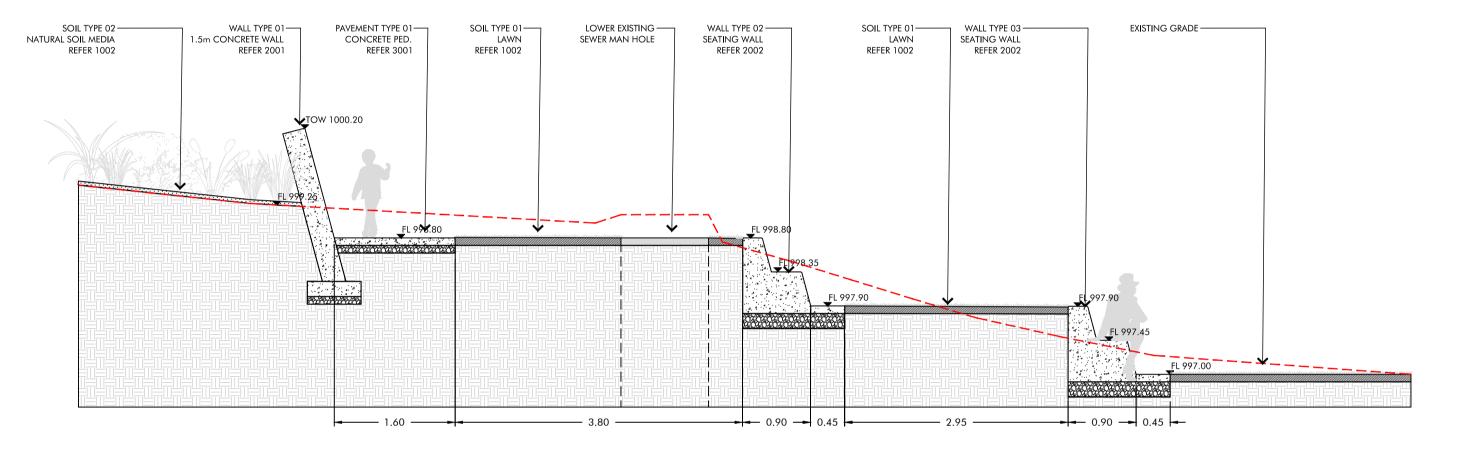


02 SECTION 02 SCALE 1:50 @ A1

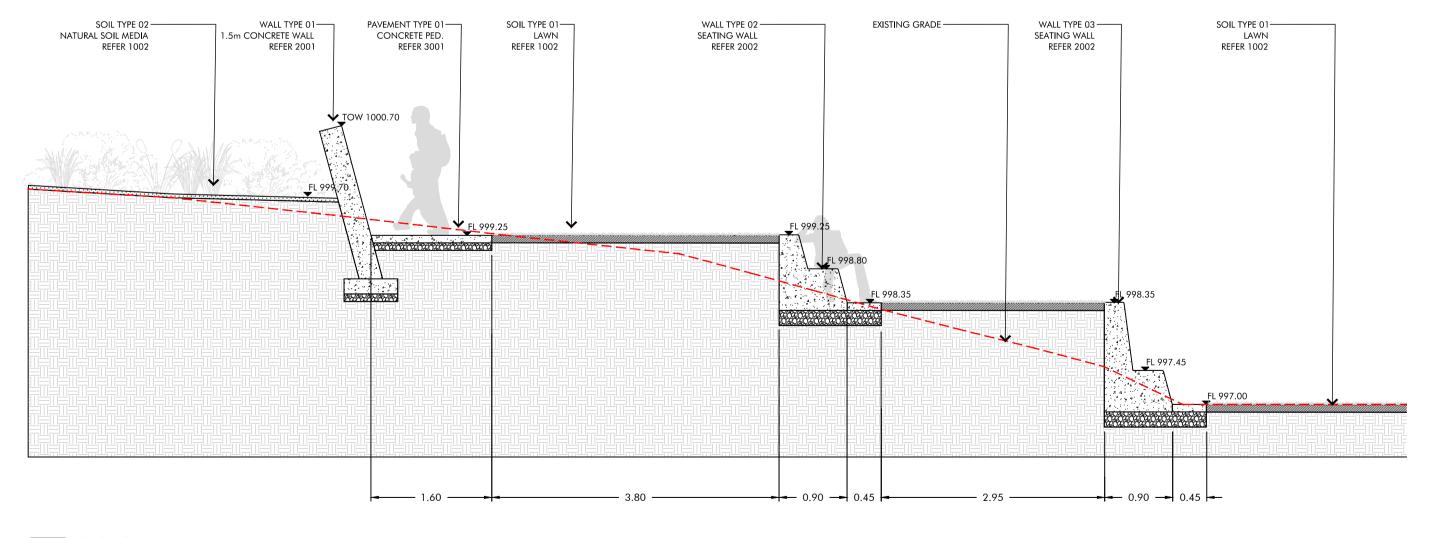


03 SECTION 03 SCALE 1:50 @ A1



Client Uralla Shire Council Project Name Uralla Parks Project No. 2145 Address Uralla, NSW

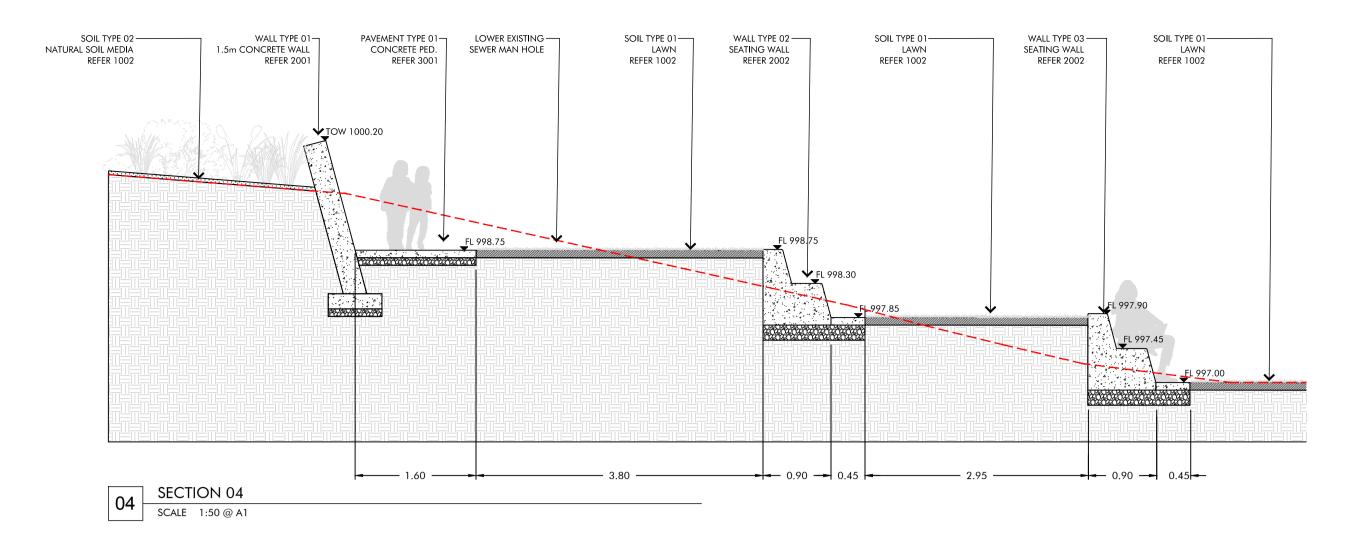

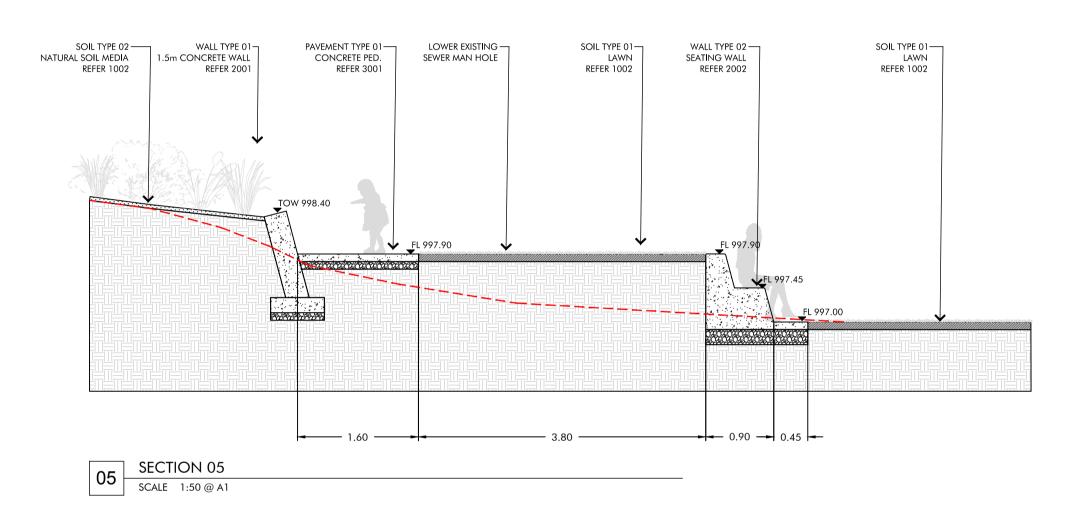

Scale Issue Log 0**1/04/2022** 21/06/2022 JV/DK 1:50 @ A1 / 1:100 @ A3 A Draft for reveiew JV/DK B For Tender 0.5 All dimensions are in metres unless otherwise noted. Date

Key Plan


Rev Description

By/Checked

Do not scale from this drawing.



Phase Tender Documentation Sheet Title Sections Sheet No. PP-SO1

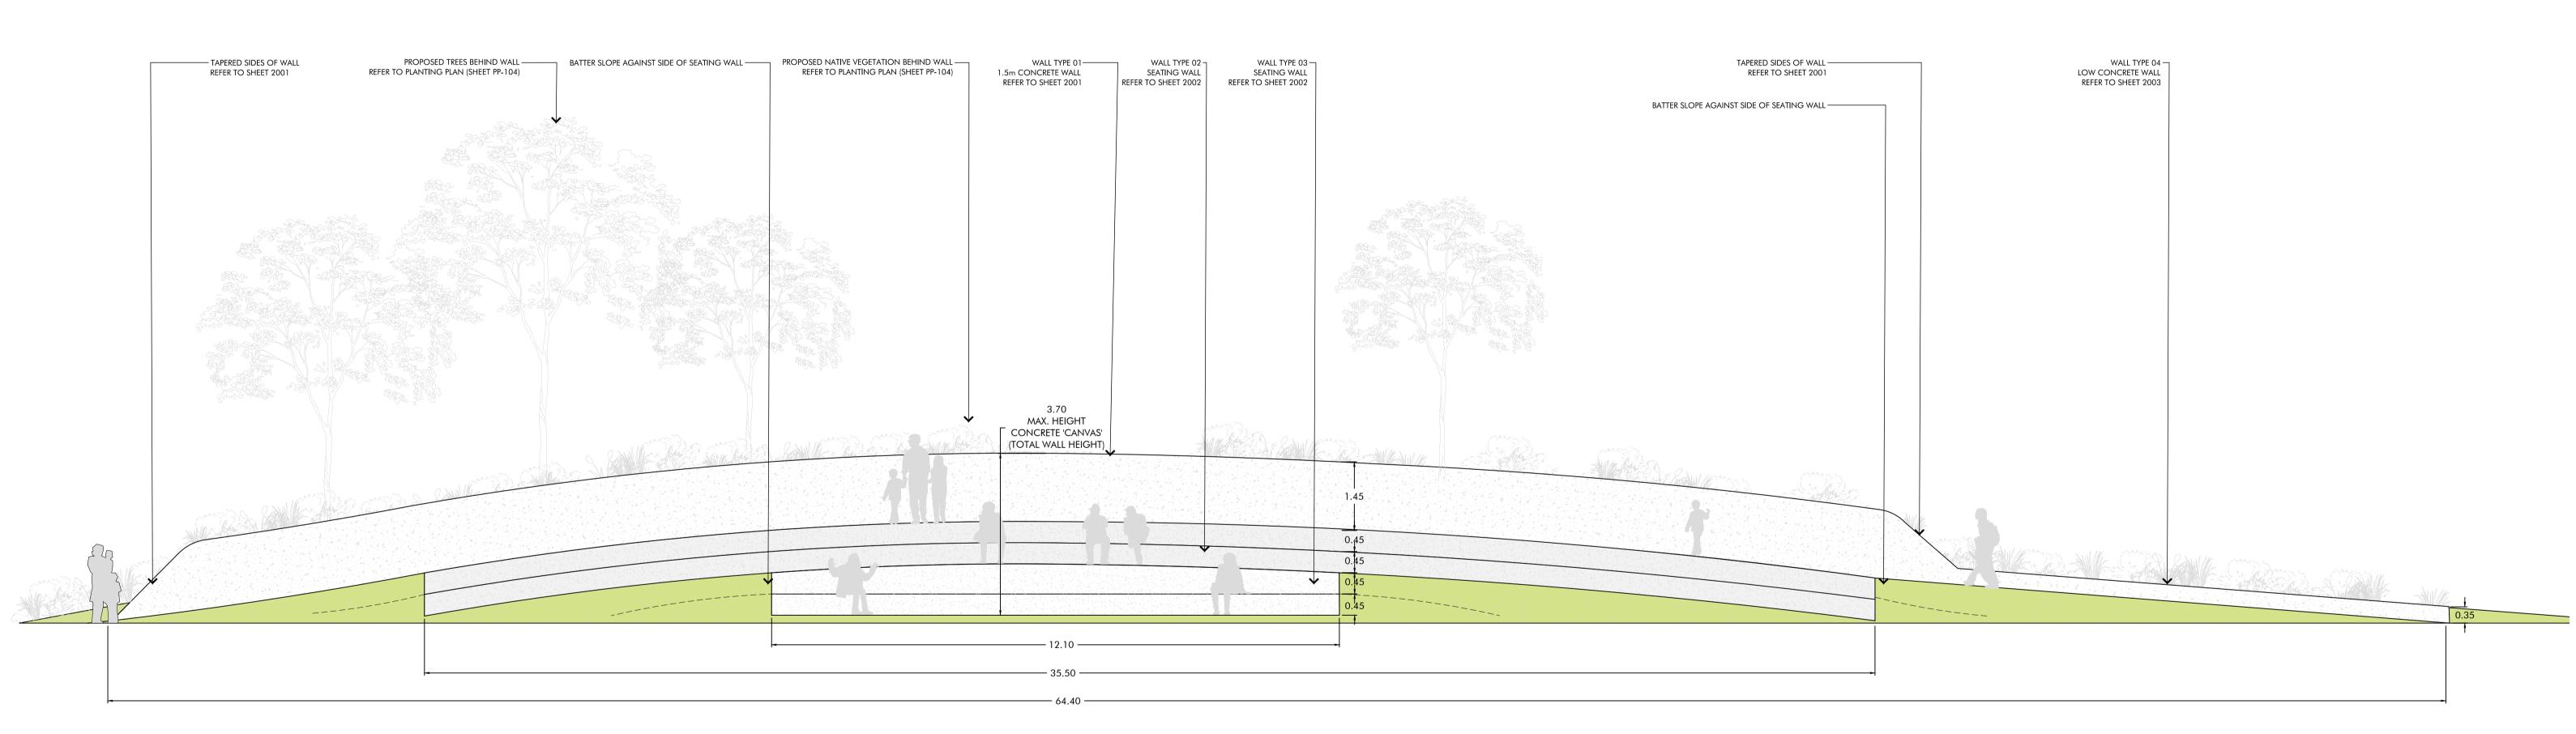

01 ELEVATION 01 - INDICATIVE ONLY SCALE 1:65 @ A1



Client Uralla Shire Council Project Name

Uralla Parks Project No. 2145 Address Uralla, NSW



Issue Log

A Draft for review B For Tender

01/06/2022 21/06/2022 JV/DK JV/DK

Scale 1:65 @ A1 / 1:130 @ A3

Rev Description


By/Checked

Date

All dimensions are in metres unless otherwise noted. Do not scale from this drawing.



Phase Tender Documentation Sheet Title Sections Sheet No. PP-SO2

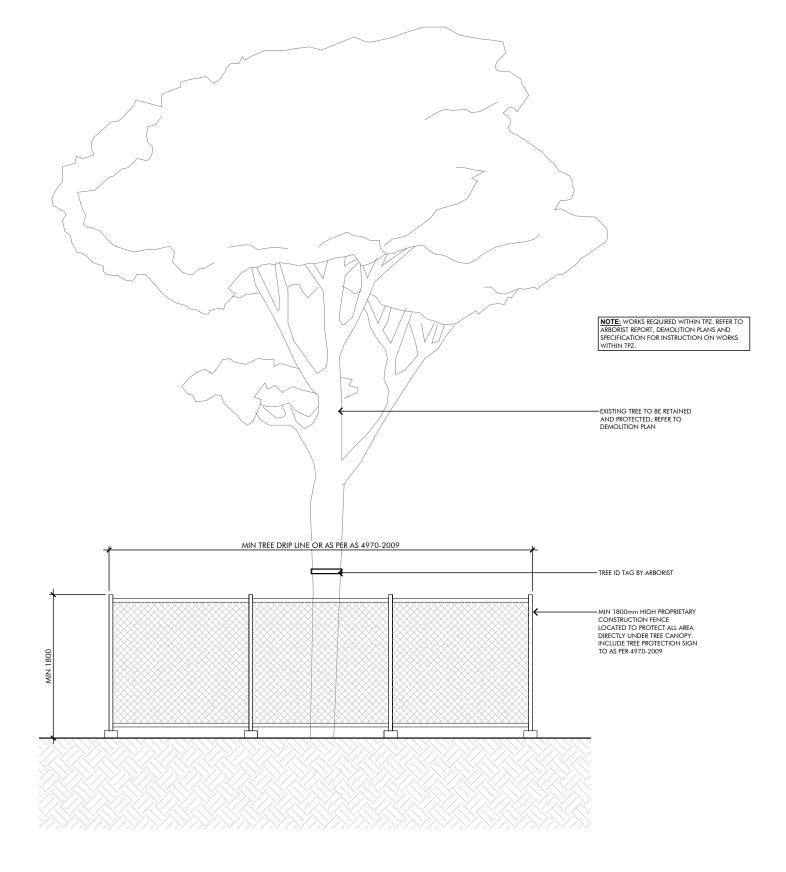



EXISTING TREE PROTECTION DETAIL

А 1:50 @ A3

REFERENCE IMAGE OF TRUNK PROTECTION В NTS



Client Uralla Shire Council Key Consultants

Project

Uralla Parks Project No. 2145 Address URALLA, NSW, 2358

Issue Log	
Rev	Date

A B

Description 01/06/2022 Draft for review 21/06/2022 For Tender

Drawn Checked

JV

JV

DK DK

Scale


AS SHOWN @ A3





Drawing status **Tender Documentation** Sheet Title Soils and Preparation; Tree Protection Detail Sheet No. 1001

Rev


В

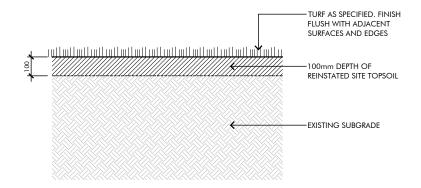


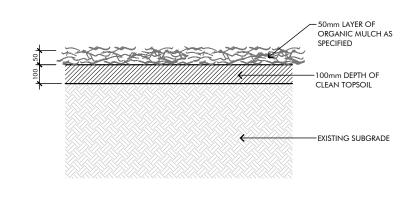

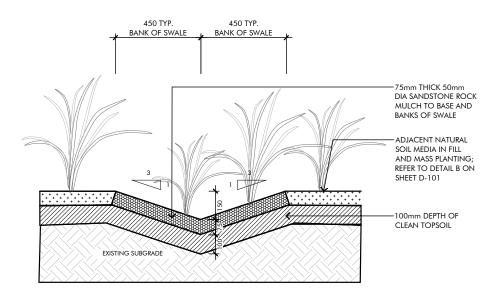



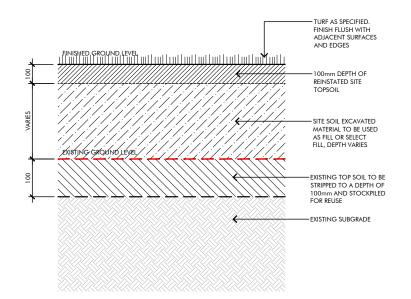

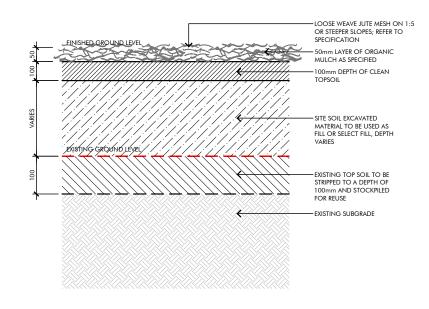





Client Uralla Shire Council Key Consultants

Uralla Parks Project No. 2145 Address URALLA, NSW, 2358

Project

Rev	Date	Description	Drawn	Checked	
A	01/06/2022	Draft for review	JV	DK	AS SHOWN @
В	21/06/2022	For Tender	JV	DK	



SOIL MEDIA TYPE 3 - SWALE


1:20 @ A3


Е



Drawing status

Tender Documentation Sheet Title Soils and Preparation; Soil Profile Types Sheet No. 1002

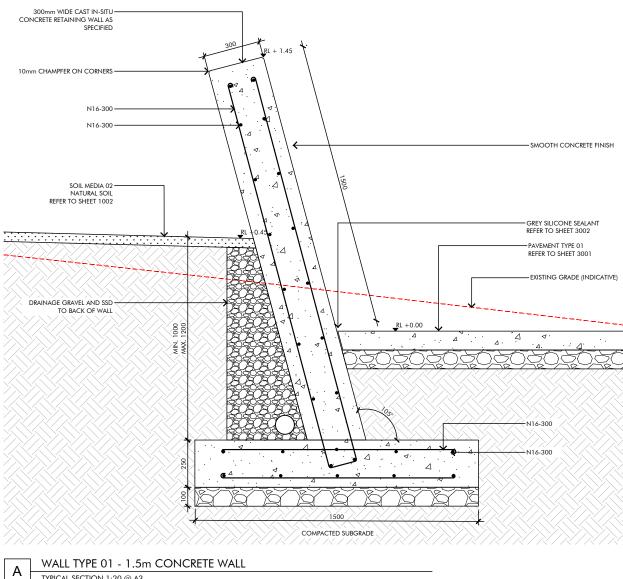

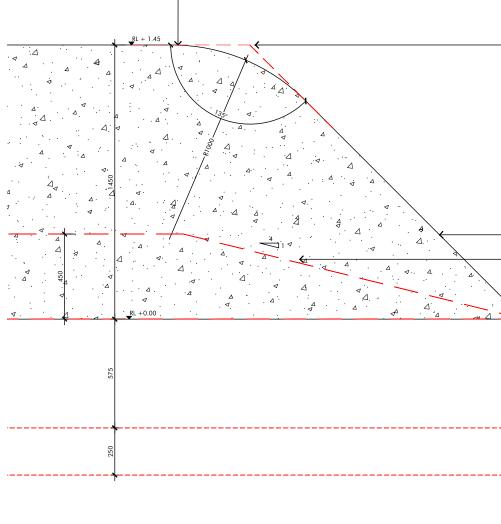

TYPICAL SECTION 1:20 @ A3

WALL TYPE 01 - 1.5m CONCRETE WALL В ELEVATION 1:20 @ A3

NOTE:



Client Uralla Shire Council

Key Consultants

Uralla Parks Project No. 2145 Address URALLA, NSW, 2358

Project

Issue Log

Rev Date A B 21/06/2022

Description

01/06/2022 Draft for review For Tender

Drawn Checked ٦٨ ٦٨

DK DK

Scale AS SHOWN @ A3

All dimensions are in millimetres unless otherwise noted. Do not scale from this drawing.

	– 300mm WIDE CAST IN-SITU CONCRETE RETAINING WALL AS SPECIFIED
	-ROUNDED CORNER (R=1000)
	– TAPER WALL TO GROUND SURFACE LEVEL
X	-FINISH LEVEL BEHIND WALL -FL OF CONCRETE PATHWAY AT BOTTOM OF WALL (INDICATIVE)
	REFER TO LEVELS & GRADING PLAN & MATERIALS & FINISHES PLAN
×	– CONTINUE TAPERED WALL UNDER GROUND LEVELS TO FOOTING –FOOTING (INDICATIVE)

1. STRUCTURAL ENGINEER TO CONFIRM DESIGN OF WALL & FOOTINGS



Drawing status **Tender Documentation** Sheet Title Walls and Edges Sheet No. 2001





Client Uralla Shire Council Key Consultants

Project Uralla Parks Project No. 2145 Address

URALLA, NSW, 2358

Issue L	og				Scale
Rev	Date	Description	Drawn	Checked	
А	01/06/2022	Draft for review	JV	DK	AS SHOWN @ A3
В	21/06/2022	For Tender	JV	DK	
					All dimensions are in millimetres unless otherw
					Do not scale from this drawing.

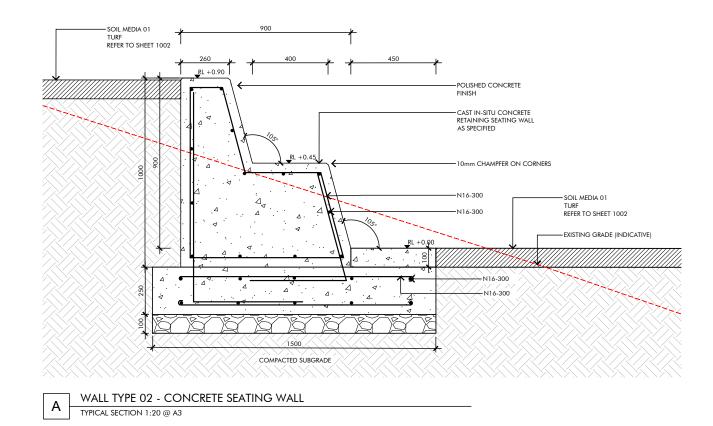

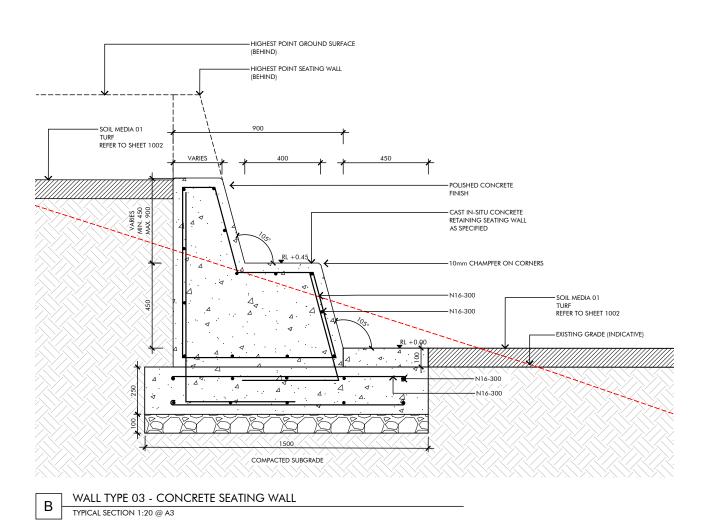

NOTE: THE HEIGHT OF THE BACKREST OF WALL TYPE 03 VARIES: MIN, 450mm AND MAX, 900mm.


1. STRUCTURAL ENGINEER TO CONFIRM DESIGN OF WALL & FOOTINGS 2. REFER LEVELS & GRADING PLAN AND SECTIONS FOR LEVELS OF WALL TYPES



Drawing status Tender Documentation Sheet Title Walls and Edges Sheet No. 2002

NOTE:

- 1. STRUCTURAL ENGINEER TO CONFIRM DESIGN OF WALL & FOOTINGS
- 2. ENSURE A SMOOTH AND CONTINUOUS TRANISTION BETWEEN 1.5M HIGH CONCRETE WALL (WALL TYPE 01) AND LOW CONCRETE WALL. (WALL TYPE 04)

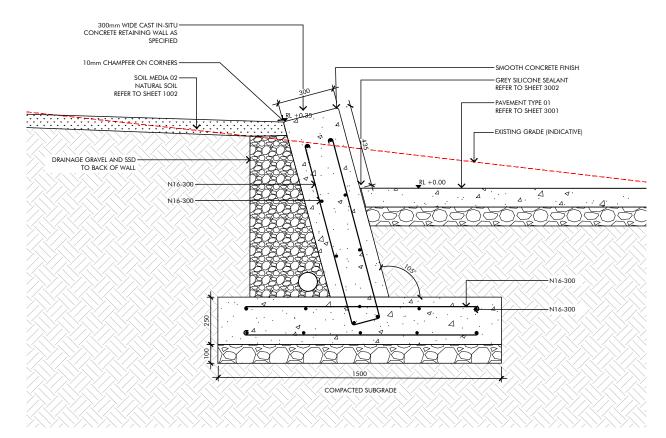

WALL TYPE 04 - LOW CONCRETE WALL

A TYPICAL SECTION 1:20 @ A3



Client Uralla Shire Council Key Consultants

Project

Uralla Parks Project No. 2145 Address URALLA, NSW, 2358

Issue Log

Rev Date Description 01/06/2022 Draft for review A B 21/06/2022 For Tender

Scale

Drawn Checked


DK DK


٦٨ ٦٨

AS SHOWN @ A3



Drawing status **Tender Documentation** Sheet Title Walls and Edges Sheet No. 2003

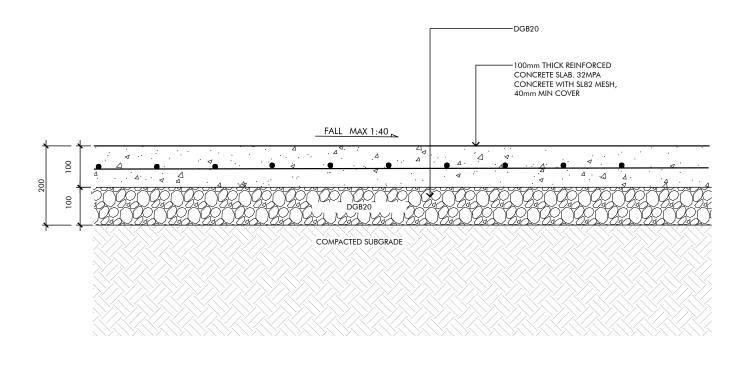

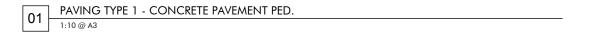





NOTE:

DK DK

- ON THE MATERIALS & FINISHES PLAN

- 4.
- TRIP HAZARDS)



Client Uralla Shire Council

Key Consultants

Project

Uralla Parks Project No. 2145 Address URALLA, NSW, 2358

Issue Log

Rev Date Description A B 01/06/2022 Draft for review 21/06/2022 For Tender

Drawn Checked JV JV

Scale

AS SHOWN @ A3

All dimensions are in millimetres unless otherwise noted. Do not scale from this drawing.


1. SANDBLAST NUMBERS OF THE FIBONACCI SEQUENCE INTO THE PAVEMENT, AS SHOWN 2. NUMBERS TO BE 700mm HIGH AND CENTRALLY PLACED ON THE PATHWAY (AS PER PLAN)

3. ENSURE REGULAR AND EQUAL SPACING BETWEEN NUMBERS

LIGHT SANDBLAST ONLY TO AVOID UNEVEN PAVEMENT SURFACE (AVOID PONDING AND



Drawing status **Tender Documentation** Sheet Title Pavements Sheet No. 3001

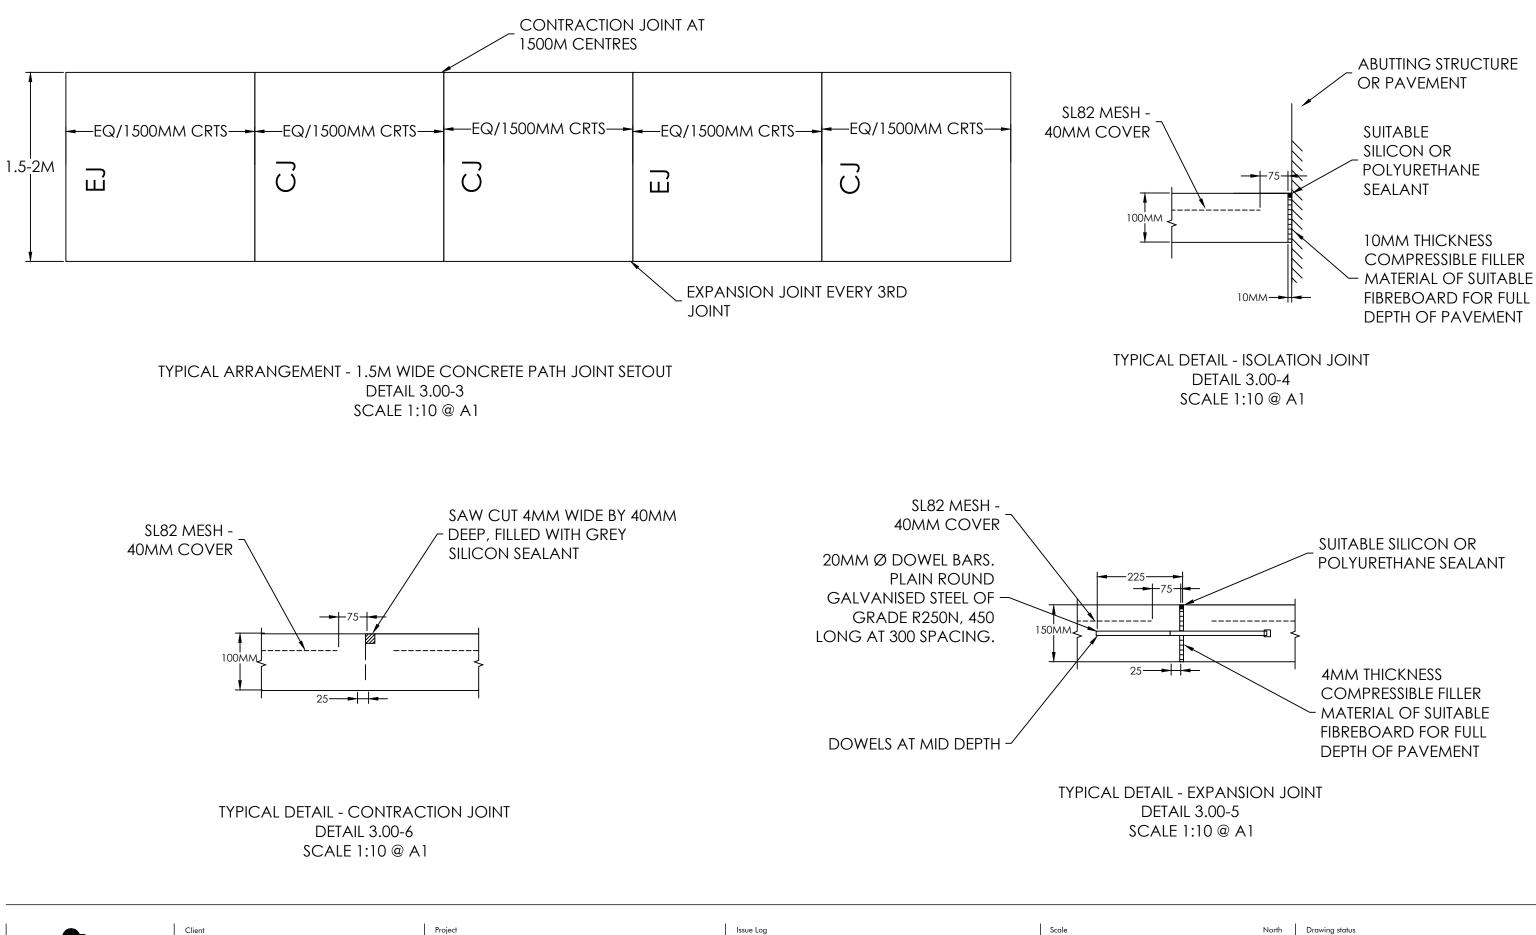

104/27-39 Ab Chippendale NSW 2008

Uralla Shire Council Key Consultants

Uralla Parks Project No. 2145 Address URALLA, NSW, 2358


Issue Log				
Rev	Date	Description	Drawn	Checked
A B	01/06/2022 21/06/2022	Draft for review For Tender	7V VL	DK DK


AS SHOWN @ A3

All dimensions are in millimetres unless otherwise noted. Do not scale from this drawina.



Tender Documentation Sheet Title Surfaces; Jointing Typical Details Sheet No. 3002

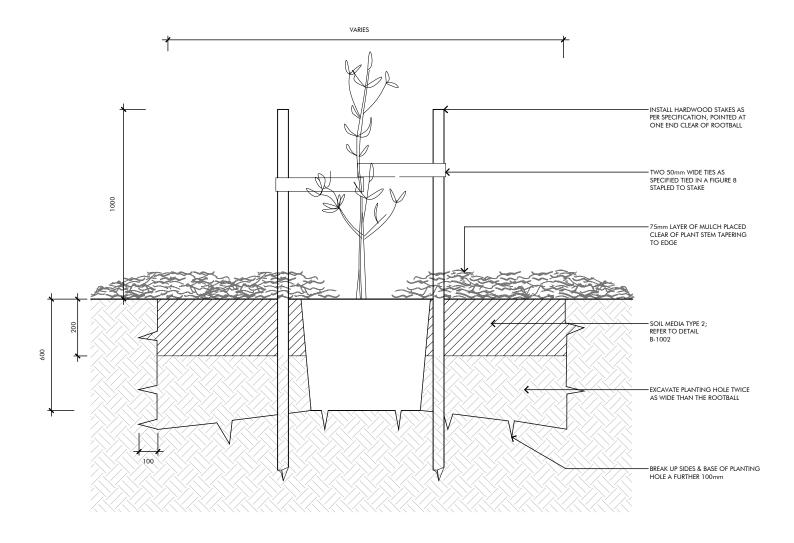

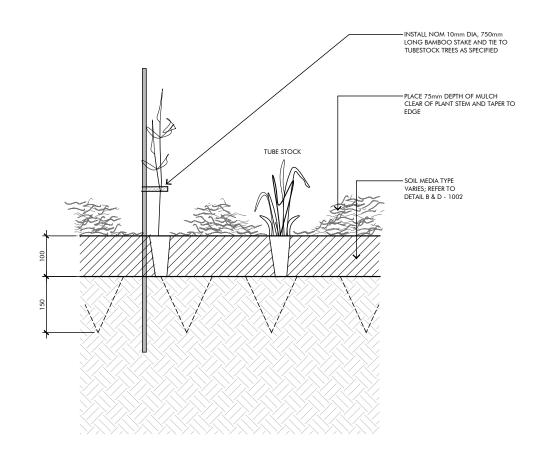

TREE PLANTING - TYPICAL DETAIL 1:20 @ A3

А

MASS PLANTING - TYPICAL DETAIL В 1:10 @ A3

104/27-39 Abercrombie Street Chippendale NSW 2008 www.civille.com.au

Client Uralla Shire Council Key Consultants

Project

Uralla Parks Project No. 2145 Address URALLA, NSW, 2358

Issue Log	
Rev	Date

A B

Description

01/06/2022 Draft for review 21/06/2022 For Tender

Drawn Checked ٦٨ ٦٨

DK DK

Scale

AS SHOWN @ A3



Drawing status Tender Documentation Sheet Title Planting; Typical Details Sheet No. 8001